





**LIGHTING KEYED NOTES: (#)**

- EXISTING LIGHTING FIXTURES ALONG WITH THEIR CIRCUITS AND CONTROLS SHALL REMAIN. E.C. TO VERIFY OPERABLE CONDITIONS IN THE FIELD. REPLACE IF FOUND INOPERABLE. BASE BID ACCORDINGLY.
- LOOP ALL EMERGENCY LIGHT FIXTURES AND EXIT SIGNS AND WIRE THEM BACK TO THE EMERGENCY LIGHTING CIRCUIT IN THE PANEL. THE CIRCUIT SHALL HAVE A LOCKOUT BREAKER.
- COORDINATE EXACT LOCATION OF TIME CLOCK WITH ARCHITECT/OWNER. ALL LIGHTING CIRCUIT SHALL PASS THROUGH T.C.
- CEILING MOUNTED DAY-LIGHT SENSOR (LS). ALL LIGHTS ARE IN PRIMARY DAYLIGHT ZONE IN THIS LIGHTING PLAN AND AUTOMATIC DAYLIGHT CONTROL WILL BE VIA LIGHT SENSOR.
- TOGGLE DISCONNECT SWITCH FOR CONNECTION TO EXTERIOR SIGNAGE. E.C. TO VERIFY THE LOCATION OF EXISTING EXTERIOR SIGNAGE IN THE FIELD AND PROVIDE NEW IF EXISTING IS NOT OPERABLE.
- E.C. TO VERIFY EXISTING CEILING MOUNTED RECEPTACLES FOR SHOW WINDOW. PROVIDE NEW IF EXISTING IS INOPERABLE.
- E.C. TO PROVIDE A NEW SWITCH BANK AS / IF REQUIRED. E.C. SHALL COORDINATE EXACT & FINAL LOCATION OF SWITCH BANK IN FIELD.

**LIGHT FIXTURE SCHEDULE GENERAL NOTES:**

- VERIFY ALL LUMINAIRE COLORS, TRIMS, LENGTHS, ETC. WITH THE ARCHITECT PRIOR TO PLACING FINAL PURCHASE ORDERS. SUBMISSION PF SHOP DRAWINGS WILL BE INTERPRETED AS HAVING BEEN COORDINATED WITH THE ARCHITECTURAL DRAWINGS.
- PROVIDE ALL LENGTHS, FEEDS, ACCESSORIES, CONNECTORS, WIRING, POWER SUPPLIES, DRIVERS ETC. FOR A COMPLETE INSTALLATION. THE E.C. SHALL VERIFY THE COMPLETE BILL OF MATERIAL WITH MANUFACTURER'S REPRESENTATIVE AND ENSURE ALL EQUIPMENT ARE INCLUDED IN BID PRICE. COORDINATE INSTALLATION WITH ARCHITECTURAL DETAILS.
- VERIFY FINAL LUMINAIRE LOCATIONS WITH OTHER CEILING MOUNTED EQUIPMENTS SUCH AS DIFFUSER WITH ARCHITECTURAL REFLECTED CEILING PLANS.
- ANY PROPOSED ALTERNATE LUMINAIRES SHALL BE APPROVED BY THE ARCHITECT PRIOR TO FINAL BID PRICING.
- SHOULD THE CONTRACTOR PROPOSE TO FURNISH MATERIALS, EQUIPMENT AND DEVICES OTHER THAN THOSE SPECIFIED AND LISTED, THE CONTRACTOR SHALL SUBMIT A WRITTEN REQUEST FOR SUBSTITUTIONS, TO THE ENGINEERS AT LEAST TEN (10) BUSINESS DAYS PRIOR TO BID OPENING. THE REQUEST SHALL BE AN ALTERNATE TO THE ORIGINAL BID AND SHALL INCLUDE A COMPLETE SPECIFICATIONS CUTSHEET SUBMITTAL AS OUTLINED IN THE SPECIFICATIONS, COMPLETE WITH DESCRIPTIVE (MANUFACTURER, BRAND NAME, CATALOG NUMBER, ETC.) AND TECHNICAL DATA FOR ALL ITEMS. INDICATE ANY ADDITIONS OR DEDUCTIONS TO THE CONTRACT PRICE WITH THE SUBSTITUTION SUBMITTAL AND ON THE BID FORM.
- ALL EMERGENCY LIGHTING FIXTURES AND EXIT SIGNS SHALL HAVE A MINIMUM OF 90 MINUTES OF BATTERY BACKUP OR AS REQUIRED BY AHJ.
- ALL THE LIGHTING FIXTURES SHALL BE LED TYPE, OPERABLE AT 120V UNLESS OTHERWISE NOTED.
- FIXTURE LOCATED ABOVE COOKING EQUIPMENT SHALL BE VAPOR-PROOF TYPE.

**LIGHTING PLAN GENERAL NOTES:**

- CONTRACTOR IS ADVISED THAT ADJUSTMENTS TO EMERGENCY AND EXIT LIGHT FIXTURE LOCATIONS/QUANTITIES MAY BE REQUIRED BY AHJ UPON FINAL INSPECTION.
- ALL EMERGENCY AND EXIT LIGHT FIXTURES SHALL BE CONNECTED AHEAD OF SWITCHED LIGHTING CIRCUIT.
- UNLESS OTHERWISE NOTED, LIGHT SWITCHES SHALL BE GANGED TOGETHER UNDER A COMMON FACEPLATE.
- ALL WIRING AND CABLES SHOULD BE PLENUM RATED. ALL WIRING LINES INCLUDING LOW VOLTAGE IN THE CEILING PLENUM SHALL BE IN CONDUIT.
- EMERGENCY LIGHT SHALL TURN ON DURING POWER FAILURE WHEREAS ALL EXIT SIGNS SHALL BE PERMANENTLY ON. WIRE THE FIXTURES ACCORDINGLY.
- THE NEUTRAL AND GROUNDING ARE NOT SHOWN ON THE DRAWING. E.C. TO PROVIDE AS REQUIRED.
- NEW EMERGENCY LIGHT FIXTURES MAKE AND MODEL SHOULD BE THE SAME AS EXISTING.

**LIGHTING FIXTURE SCHEDULE**


SYMBOL	FIXTURE TAG	DESCRIPTION/NAME	SUPPLIER/MANUFACTURE	COLLECTION/ MODEL #	WATTAGE
⊕	L1	FOH PENDANT	SCHNEID STUDIO	THE JUNIT LAMP; DROP	6 WATT
⊖	L2	RECESS DOWNLIGHT	WAC LIGHTING	HR-LED212E	4 WATT
⊙	L3	RECESSED LIGHTING	VISUAL COMFORT	MODEL: ENCL3RFA-930W-W	8 WATT
⊔	L4	UNDER CABINET LIGHT	ETI	UC-42-15-930-SV-D (53506111)	22 WATT

**ABBREVIATIONS :**

- N = NEW LIGHT FIXTURE
- E = EXISTING LIGHT FIXTURE

**MULTILEVEL LIGHTING CONTROL:**

THE LOWER CASE LETTERS "a" "b" & "c" MARKED NEAR THE LIGHTING FIXTURES INDICATES THE SWITCH CONTROLS. THE SWITCHES AND SENSORS (OCCUPANCY SENSOR & DAY LIGHT SENSOR SHOWN ON THE LIGHTING PLAN) SHALL BE CONNECTED SUCH THAT THE DIFFERENT LEVEL OF ILLUMINATION CAN BE ACHIEVED COMPLYING THE REQUIREMENT OF MULTILEVEL SWITCHING REQUIRED UNDER 130.1 (b) OF TITLE 24. THE SENSORS SHALL MEET THE CONTROL FUNCTION REQUIREMENTS.

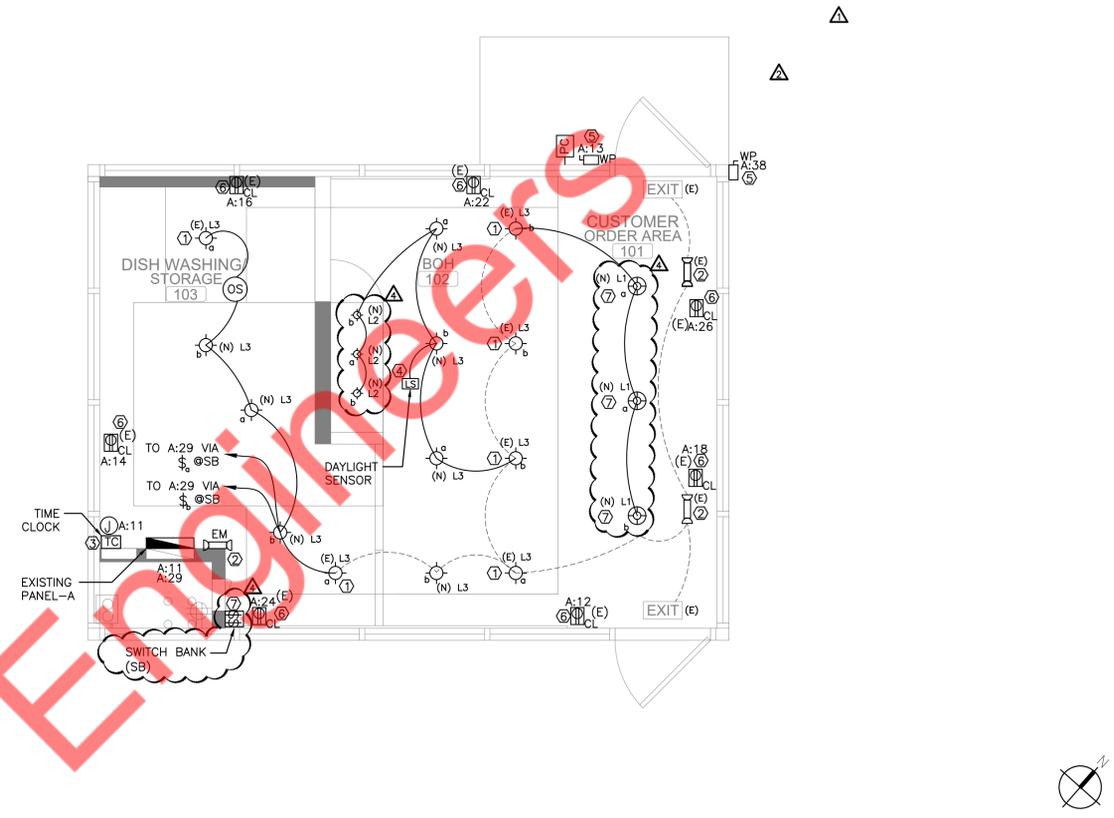

**ELECTRICAL LIGHTING PLAN**

SCALE 3/8"=1'-0" 1

ID	NAME	MFG.	MODEL /SIZE	VOLTAGE	PHASE	WATT	AMPS	NEMA	NOTES
E01	LINEA PB W SCALE BUILT IN	LA MARZOCO	PB 2 GROUP	208	1	4600	30	-	1,2,5,6
E02	GRINDER (FILTER)	MAHLKONIG	EK43	208	1	1300	13	-	1,2,5,6
E03	MAZZER ROBUR	ESPRESSO PARTS	ROBUR 5	120	1	800	6.6	-	1,2,5,6
E07	SINGLE COFFEE BREWER	CURTIS	CBS-2251 NG	208	1	6000	25.5	-	1,2,5,6
E10	ICE MACHINE	MANITOWOC	IT1200	208	1	2950	14.2	-	1,2,5,7
E12	BLENDER	BLEND TEC	CONNOISSEUR 825 BLENDER	120	1	1800	15	NEMA 5-15P	1,2,5,6
E13	POS	SQUARE	NOTE: INCLUDED IN SQUARE POS KIT	115				NEMA 5-15P	1,2,4,7
E14	UNDER COUNTER REFRIGERATOR	BEVERAGE AIR	UCR20HC	115	1	300	2.5	NEMA 5-15P	1,2,6
E15	REACH IN UNIT	FEDRAK	UCBSA36335	120	1	1480	12.3	NEMA 5-20P	1,2,6
E18	REACH IN UNIT	TURBO AIR	TOM-36UC-W-N 36" White Drop-In Refrigerated Open Display Case Merchandiser	115	1	600	7.5	NEMA 5-15P	1,2,6
E19	SQUARE PRINTER	SQUARE	NOTE: INCLUDED IN SQUARE POS KIT	115				NEMA 5-15P	1,2,4,6
E20	PUOPRESS	PUOQ1	5.6" X 7.7" X 11.3"	115	1	76		NEMA 5-15P	1,2,5,6
E23	AIR CURTAIN	SCHWANKAIR	AC-1036-12-6K-36"	120	1	380	3.2	NEMA 5-15P	1,2,5,6
E27	UNDER COUNTER SINGLE DOOR FREEZER	BEVERAGE AIR	UCF20HC	115	1	300	2.5	NEMA 5-15P	1,2,5,6
P03	WATER HEATER	DEL-50	48 GAL						1,2,5,6
P04	WATER FILTRATION SYSTEM	3M	TFS450, 30GAL						

**NOTES:**

- REFER TO THE PANEL SCHEDULE FOR CIRCUIT NUMBER INFORMATION.
- CONTRACTOR TO COORDINATE WITH MANUFACTURER INSTALLATION MANUAL FOR ALL POWER AND COMMUNICATION CONNECTION REQUIREMENTS.
- ALL EQUIPMENT UNDER THE HOOD SHALL HAVE SHUNT TRIP BREAKER.
- COORDINATE EXACT MAKE/MODEL NUMBER WITH THE OWNER/ARCHITECT.
- COORDINATE THE EXACT CONNECTION TYPE WITH THE VENDOR BEFORE BID.
- COORDINATE MOUNTING HEIGHT OF THE RECEPTACLE OR DISCONNECTION WITH THE ARCHITECT/OWNER.


**ELECTRICAL POWER PLAN GENERAL NOTES:**

- ALL THE BRANCH WIRING SHALL BE COPPER. THE INSULATION SHALL BE RATED FOR THE AREA OF THE USE.
- POWER AND LOCATION OF ALL THE MECHANICAL AND PLUMBING UNITS SHALL BE COORDINATED WITH THE RESPECTIVE CONTRACTORS BEFORE BID.
- ELECTRICAL OUTLETS PLACED ON BOTH SIDES OF THE WALL PARTITION TO BE LOCATED OFFSET OF EACH OTHER.
- ELECTRICAL OUTLETS AND DEVICES LOCATED IN DEMISING WALLS TO HAVE FIRE RATING.
- PURTY AROUND THE BOX TO MAINTAIN PARTITION FIRE RATING.

- THE DISCONNECT SWITCHES FOR THE BRANCH CIRCUIT SHOWN ON THE PLAN SHALL BE RATED EQUAL TO OR HIGHER THAN THE BREAKER RATING. REFER BREAKER RATING IN THE PANEL SCHEDULE AND PROVIDE DISCONNECT AS NEEDED.
- GFI MARKED ON THE PLAN INDICATES THAT THE CIRCUIT SHALL BE GFI PROTECTED. E.C. SHALL PROVIDE A GFI RECEPTACLE IN THE READILY ACCESSIBLE LOCATION. PROVIDE GFI BREAKER IN THE PANEL IF EITHER THE RECEPTACLE IS NOT AVAILABLE OR NOT ACCESSIBLE WHEN INSTALLED IN THE DESIRED LOCATION.

**ELECTRICAL POWER PLAN KEYED WORK NOTES:**

- QUAD & DATA OUTLET FOR DESK. E.C. TO VERIFY EXACT LOCATION AND MOUNTING HEIGHT OF OUTLETS WITH ARCHITECT/OWNER PRIOR TO BID.
- E.C. SHALL VERIFY WITH THE ARCHITECT/OWNER FOR THE EXACT LOCATION OF THE EXISTING PANEL ALSO, ENSURE CLEAR WORKING AND DEDICATED SPACE HAVE BEEN PROVIDED PER CODE.
- COORDINATE EXACT LOCATION AND MOUNTING HEIGHT WITH OWNER/ARCHITECT.
- E.C. SHALL COORDINATE WITH THE MECHANICAL CONTRACTOR FOR THE EXACT LOCATION AND ELECTRICAL CONNECTION REQUIREMENT OF THE UNIT IN THE FIELD. PROVIDE CIRCUIT AND CONTROL AS REQUIRED.
- PROVIDES QUAD AND DATA/TEL COMBINATION FOR THE IT RACK. COORDINATE WITH THE ARCHITECT/OWNER/SERVICE PROVIDER FOR OTHER REQUIREMENTS. PROVIDE CONDUIT AND CONNECTION AS REQUIRED.

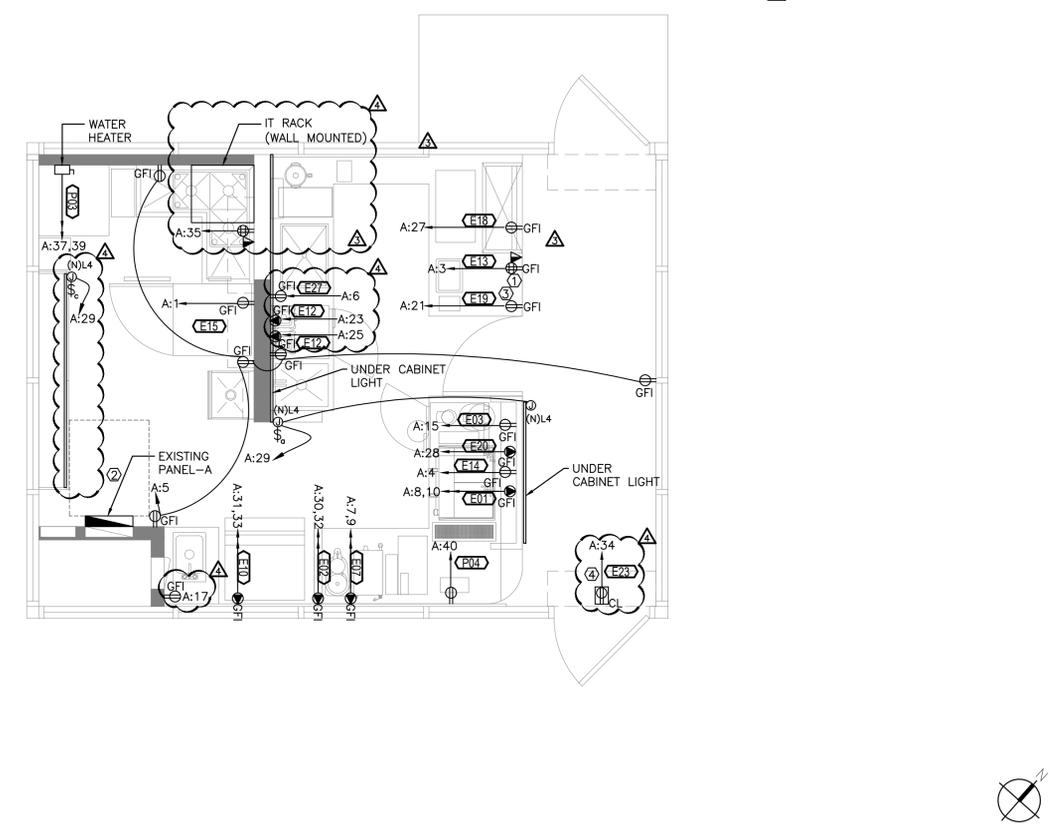

**ELECTRICAL POWER PLAN**

SCALE 3/8"=1'-0" 2



**Issue For Description:**

Issue Date: 09.10.24

**Revisions:**

NO.	DESCRIPTION	DATE
1	ELECTRICAL COMMENTS	10.01.24
2	CITY COMMENTS	10.02.24
3	HEALTH DEPARTMENT COMMENTS	10.21.24
4	HEALTH DEPT/CLIENT REVISIONS	11.05.24


**Sheet Title:**

**ELECTRICAL LIGHTING AND POWER PLAN**

**Sheet Number:**

**E100**



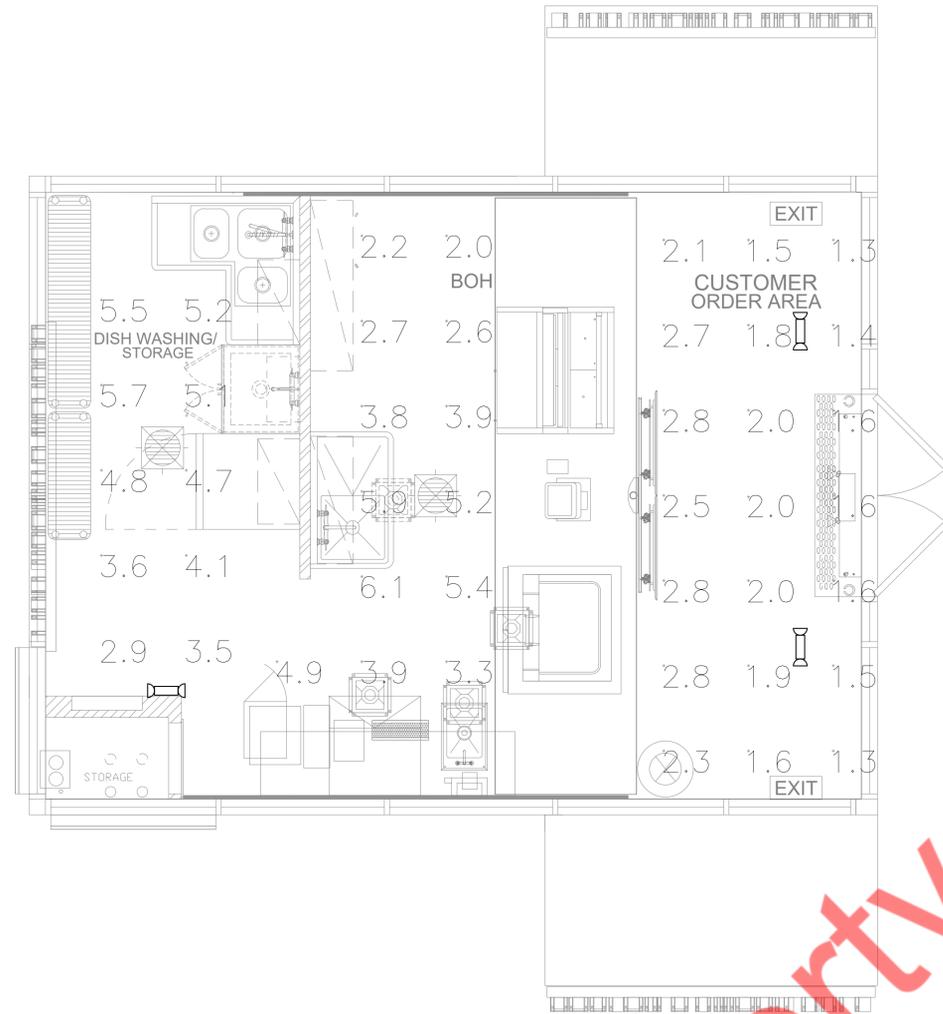

EM. LUMINAIRE SCHEDULE									
Symbol	Label	Qty	Catalog Number	Description	Lamp	File	Lumens	LLF	Watts
	EM	3	ELM6L	ELM6L SP1100L	ONE 5.3-WATT LED	ELM6L.ies	564	0.70	4.2

STATISTICS						
Description	Symbol	Avg	Max	Min	Max/Min	
CUSTOMER AREA	+	2.0 fc	2.8 fc	1.3 fc	2.2:1	
FOOD SERVICE AREA	+	4.0 fc	6.1 fc	2.0 fc	3.1:1	
STORAGE	+	4.5 fc	5.7 fc	2.9 fc	2.0:1	

Property of NY Engineers

Project Owner:



Issue For Description:

Issue Date:

09.10.24

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Sheet Title:

EMERGENCY PHOTOMETRIC PLAN

Sheet Number:

E400



**PLUMBING LEGEND**

SYMBOL	DESCRIPTION
--- SAN ---	SANITARY SEWER (UNDERFLOOR)
--- G SAN ---	GREASE SANITARY
-----	VENT PIPING
-----	COLD WATER
-----	HOT WATER
-----	RECIRCULATING HOT WATER
--- CD ---	CONDENSATE DRAIN
	CHECK VALVE
	PIPE DOWN
	PIPE UP
	UNION
	ISOLATION VALVE
	CAP ON END OF PIPE
	CLEANOUT
	POINT OF NEW CONNECTION

**PLUMBING ABBREVIATIONS**

CO	CLEANOUT
CW	COLD WATER
HW	HOT WATER
HWR	HOT WATER RETURN
SAN	SANITARY
V	VENT
TYP.	TYPICAL
DN	DOWN
EX.	EXISTING
AFF	ABOVE FINISH FLOOR
SQ. FT.	SQUARE FEET
WH-1	WATER HEATER
RPZ/BFP	BACKFLOW PREVENTER
ET-1	EXPANSION TANK
RCP-1	RECIRCULATION PUMP
FFD	FUNNEL DRAIN
PS	PREP SINK
HS	HAND SINK

**PLUMBING DRAWING LIST**

PO01	PLUMBING SYMBOLS, ABBREVIATIONS & NOTES
P100	PLUMBING PLANS
P200	PLUMBING DETAILS
P300	PLUMBING SCHEDULES AND RISERS
P400	TITLE 24 (1 OF 2)
P401	TITLE 24 (2 OF 2)

**APPLICABLE CODES**

- 2022 CALIFORNIA ENERGY CONSERVATION CODE
- 2022 CALIFORNIA MECHANICAL CODE.
- 2022 CALIFORNIA PLUMBING CODE.
- 2022 CALIFORNIA ELECTRICAL CODE.
- 2022 CALIFORNIA FUEL GAS CODE.
- 2022 CALIFORNIA BUILDING CODE.

**BUILDING DEPARTMENT PLUMBING NOTES**

- ALL PLUMBING SYSTEMS (SANITARY, WASTE, VENT, WATER, STORM) AND ASSOCIATED EQUIPMENT SHALL BE INSTALLED, OPERATED AND MAINTAINED IN ACCORDANCE WITH THE REQUIREMENTS OF 2022 CALIFORNIA PLUMBING CODE.
- INSTALLATION OF UNDERGROUND PIPING SHALL BE IN ACCORDANCE WITH THE REQUIREMENTS OF SECTION PC 701
- PROTECTION OF PIPING AND PLUMBING SYSTEM COMPONENTS AS PER SECTION PC 312.
- TRENCHING, EXCAVATION AND BACKFILL AS PER SECTION PC 314.
- RODENT PROOFING AS PER PC 312.12
- MATERIALS USED IN PLUMBING SYSTEMS SHALL BE IN ACCORDANCE WITH THE REQUIREMENTS OF SECTION PC 312, PC 604, PC 701, PC 903, PC 1102.
- EQUIPMENT CONNECTIONS AND JOINING OF PIPING SHALL BE IN ACCORDANCE WITH THE REQUIREMENTS OF CHAPTERS 4, 5, 6, 7 AND 9.
- DEEP SEAL TRAPS FOR FLOOR DRAINS SHALL BE PROVIDED AS PER PC 1002, AND CLEAN-OUTS SHALL BE INSTALLED IN ACCORDANCE WITH THE REQUIREMENTS OF SECTION PC 708
- DRAINAGE PIPE CLEANOUTS AS PER SECTION PC 719.
- VERTICAL AND HORIZONTAL PIPING SHALL BE SUPPORTED IN ACCORDANCE WITH THE REQUIREMENTS OF SECTION PC 313

- WATER SUPPLY SYSTEMS SHALL BE INSTALLED AND MAINTAINED IN ACCORDANCE WITH THE REQUIREMENTS OF CHAPTER 6 SECTION PC 601-603, 604, 606, 607, 608, 610
- THE SANITARY DRAINAGE SYSTEM SHALL BE SIZED AND INSTALLED IN ACCORDANCE WITH THE REQUIREMENTS OF CHAPTER 7 SECTION PC 701, 704, 705, 706, 707, 708, 711.
- VENT PIPING FOR THE SANITARY DRAINAGE SYSTEM SHALL BE INSTALLED IN ACCORDANCE WITH THE REQUIREMENTS OF CHAPTER 9 SECTIONS PC 901 THROUGH PC 912 THROUGH PC 917
- INSPECTION AND TESTING OF PLUMBING SYSTEMS SHALL BE IN ACCORDANCE WITH SECTION PC 107.

**PLUMBING SPECIFICATION**

**1. BASIC PLUMBING REQUIREMENTS, MATERIALS AND METHODS**

**1.01 SCOPE**

- PROVIDE ALL MATERIAL, TOOLS, SUPERVISION AND LABOR INCLUDING ALL MISCELLANEOUS AND INCIDENTAL ITEMS REQUIRED FOR COMPLETE AND OPERABLE PLUMBING INSTALLATIONS AS SHOWN OR DESCRIBED ON THE DRAWINGS AND IN THESE SPECIFICATIONS.
- THE CONTRACTOR SHALL BE RESPONSIBLE FOR THE PROTECTION OF ALL EXISTING AND NEW CONDITIONS AND MATERIALS WITHIN THE CONSTRUCTION AREA. ANY DAMAGE CAUSED BY THE CONTRACTOR SHALL BE REPAIRED TO THE OWNER'S SATISFACTION.
- OBTAIN ALL PERMITS, PAY ALL PERMIT FEES AND SCHEDULE ALL REQUIRED INSPECTIONS. COPIES OF ALL PERMITS AND INSPECTION CERTIFICATES SHALL BE FORWARDED TO THE OWNER FOR RECORD.
- THE GENERAL CONDITIONS OF THE CONTRACT AND ALL DIVISION 1 REQUIREMENTS APPLY TO THE WORK OF THIS SECTION.

- THE CONTRACTOR SHALL VISIT THE SITE PRIOR TO SUBMITTING BID TO DETERMINE CONDITIONS AND THE EXTENT OF THE WORK. BY COMMENCING WORK, THE CONTRACTOR ACKNOWLEDGES HIS CONFIRMATION OF ALL CONDITIONS AS ACCEPTABLE WITH REFERENCE TO HIS CONTRACT, SCOPE OF WORK AND BID PRICE SUCH THAT NO ADDITIONAL COMPENSATION SHALL BE FORTHCOMING FOR UNFORESEEN EXISTING CONDITIONS.

- IN ALL AREAS SUBJECT TO FREEZING CONDITIONS, THE CONTRACTOR SHALL PROVIDE FREEZE PROTECTION FOR ALL DOMESTIC WATER PIPING INSTALLED UNDER HIS CONTRACT.

- ALL ELECTRICAL REQUIREMENTS SHALL BE COORDINATED WITH THE CONTRACTOR FOR ELECTRICAL WORK. THIS CONTRACTOR IS RESPONSIBLE FOR ALL LOW VOLTAGE WIRING FOR EQUIPMENT INSTALLED UNDER HIS CONTRACT. THE CONTRACTOR FOR ELECTRICAL WORK IS RESPONSIBLE FOR LINE VOLTAGE POWER WIRING ONLY.

- COLOR AND FINISH SELECTIONS FOR ALL MATERIALS, INCLUDING PAINTING OF PIPING, SHALL BE AS DIRECTED AND/OR APPROVED BY THE ARCHITECT.

- MINOR DETAILS NOT SHOWN OR SPECIFIED, BUT NECESSARY FOR THE PROPER AND ACCEPTABLE CONSTRUCTION, INSTALLATION OR OPERATION OF ANY PART OF THE WORK AS DETERMINED BY THE ENGINEER SHALL BE INCLUDED AS IF SPECIFIED OR INDICATED ON THE DRAWINGS.

- THIS CONTRACTOR SHALL BE RESPONSIBLE FOR COORDINATING ALL REQUIREMENTS FOR THE INSTALLATION, CONNECTION, EXTENSION OR MODIFICATION TO ALL UTILITY SERVICES WITH RESPECTIVE PROVIDERS INCLUDING PAYMENT OF ALL ASSOCIATED FEES.

- THE CONTRACTOR IS RESPONSIBLE FOR ALL PAINTING ASSOCIATED WITH CUTTING AND PATCHING. ALL PAINTING IN AREAS WITH COMPLETE FINISH RENOVATIONS SHALL BE PROVIDED BY THE GENERAL CONTRACTOR.

**1.02 SUBMITTALS**

- SUBMITTAL REQUIREMENTS SHALL BE COORDINATED WITH THE ARCHITECT AND AUTHORITIES HAVING JURISDICTION, UNLESS OTHERWISE DIRECTED, CONTRACTOR SHALL PROVIDE SUBMITTALS AS LISTED BELOW.

- PIPE AND FITTINGS
- VALVES
- HANGERS AND SUPPORTS
- PLUMBING PIPING LAYOUT
- TESTS
- PLUMBING FIXTURES
- WATER HEATERS & ACCESSORIES
- MIXING VALVES
- ALL SCHEDULED PLUMBING EQUIPMENT

- SUBMITTALS FROM SUPPLIERS OR MANUFACTURERS WHICH DO NOT BEAR THE STAMP OF THE SUBMITTING CONTRACTOR INDICATING THAT THE CONTRACTOR HAS REVIEWED THE SUBMITTAL FOR CONFORMANCE WITH THE PROJECT REQUIREMENTS WILL BE RETURNED REJECTED.

- THE ENGINEER'S REVIEW OF SUBMITTALS IS A COURTESY WHICH DOES NOT RELIEVE THE CONTRACTOR FROM CONFORMING WITH THE CONSTRUCTION DOCUMENTS, REGARDLESS OF THE ACTION INDICATED BY THE SHOP DRAWINGS STAMP.

- REVIEW OF SHOP DRAWINGS BY THE ENGINEER SHALL BE LIMITED TO THE INITIAL REVIEW, AND A SECOND REVIEW OF ANY REQUIRED RESUBMITTED DATA. IF THE ENGINEER IS REQUIRED TO REVIEW SHOP DRAWINGS FOR A THIRD (OR MORE) SUBMISSION OF THE SAME ITEM, THE CONTRACTOR SHALL BE LIABLE FOR COMPENSATING THE ENGINEER FOR THESE SUBSEQUENT REVIEWS AS PER THE ENGINEER'S CURRENT HOURLY RATE SCHEDULE.

- SUBMIT PROOF OF APPROVAL AND/OR CONFIRMATION OF SATISFACTORY TEST RESULTS TO THE OWNER AND THE ARCHITECT.

- SUBMIT TO THE OWNER'S MAINTENANCE PERSONNEL OPERATION AND MAINTENANCE DATA FOR ALL SYSTEM COMPONENTS, SERVICING REQUIREMENTS, INSPECTION DATA, REPLACEMENT PART NUMBERS AND AVAILABILITY AND CONTACT INFORMATION FOR SERVICE/SUPPLY COMPANY.

- FOR ALL BELOW GRADE PIPING WHERE ACTUAL INSTALLATION DEVIATES FROM CONSTRUCTION DRAWINGS, THE CONTRACTOR SHALL PROVIDE AS-BUILT DRAWINGS INDICATING BELOW GRADE PIPE LOCATIONS DIMENSIONED TO NEAREST COLUMN LINES.

- RECORD AS-BUILT DRAWINGS SHALL BE SUPPLIED TO THE OWNER/TENANT AFTER COMPLETION OF THE WORK SHOWING ANY ALTERATIONS, ADDITIONS AND/OR DELETIONS TO THE SYSTEM(S) INSTALLED.

**1.03 SUBSTITUTIONS**

- ALL EQUIPMENT SHALL BE PRODUCTS OF THE SPECIFIED MANUFACTURER OR MANUFACTURERS. ALL BIDS SHALL BE BASED ON THE SPECIFIED MANUFACTURER OR MANUFACTURER'S EQUIPMENT. FOR SUBSTITUTIONS OF OTHER MANUFACTURER'S EQUIPMENT TO BE CONSIDERED, THE SUBSTITUTION MUST BE INDICATED PRIOR TO BIDDING WITH THE REASON FOR THE PROPOSED SUBSTITUTION IDENTIFIED, AND THE PROPOSED CREDIT TO THE OWNER INDICATED. THE ENGINEER SHALL DETERMINE THE ACCEPTABILITY OF ANY PROPOSED SUBSTITUTIONS.

- THE CONTRACTOR ASSUMES ALL RESPONSIBILITY FOR COORDINATING THE WORK OF OTHER TRADES WHICH MAY BE AFFECTED BY SUBSTITUTIONS, INCLUDING ALL RELATED COSTS.

**1.05 DEFINITIONS**

- FURNISH: TO PURCHASE, PROCURE, ACQUIRE AND DELIVER, COMPLETE WITH RELATED ACCESSORIES.
- INSTALL: TO ERECT, MOUNT AND CONNECT, COMPLETE WITH RELATED ACCESSORIES.
- PROVIDE: TO FURNISH AND INSTALL.
- PLUMBING CONTRACTOR, THE CONTRACTOR, THIS CONTRACTOR: THE CONTRACTOR FOR PLUMBING WORK WHICH IS SPECIFIED HEREIN AND SHOWN ON THESE DRAWINGS.

**1.06 DRAWINGS**

- THE DRAWINGS ARE DIAGRAMMATIC AND ARE INTENDED TO ILLUSTRATE THE GENERAL ARRANGEMENT AND ROUTING OF PIPING AND GENERAL LOCATIONS OF EQUIPMENT. PRECISE LOCATIONS OF EQUIPMENT, RISERS AND STACKS, AND ROUTING AND ELEVATION OF ALL PIPING SYSTEMS SHALL BE COORDINATED IN THE FIELD WITH THE ARCHITECT, ARCHITECTURAL DRAWINGS, THE WORK OF OTHER TRADES, EXISTING AND NEW BUILDING CONDITIONS AND/OR THE PREFERENCES OF THE OWNER/TENANT AS CONSTRUCTION PROCEEDS. ALL PIPING SHALL BE INSTALLED CONCEALED IN FINISHED SPACES, UNLESS NOTED OTHERWISE.

- PROVIDE ALL NECESSARY INCIDENTAL MATERIALS AND ACCESSORIES REQUIRED TO MAKE THE WORK COMPLETE IN ALL RESPECTS, EVEN IF NOT PARTICULARLY SHOWN OR SPECIFIED.

- REFER TO PLUMBING EQUIPMENT/FIXTURE SCHEDULE ON THE DRAWINGS FOR ALL FIXTURE AND EQUIPMENT SPECIFICATIONS.

- REFER TO FIXTURE CONNECTION SIZE SCHEDULE FOR ALL FIXTURE ROUGHING SIZE REQUIREMENTS.

- VERIFY ALL INDICATED CONDITIONS BEFORE STARTING WORK AND REPORT ANY DISCREPANCIES. THE DRAWINGS REFLECT CONDITIONS WHICH CAN BE REASONABLY INTERPRETED FROM THE EXISTING VISIBLE CONDITIONS OR FROM DRAWINGS AND INFORMATION FURNISHED BY THE OWNER.

- LOCATE ALL FIXTURES AND EQUIPMENT AS PER THE FINAL ARCHITECTURAL DRAWINGS.

**1.07 PRODUCTS**

- SANITARY AND VENT PIPING:
  - ABOVE GRADE PIPING SHALL BE HUBLESS CAST IRON PIPE WITH STAINLESS STEEL COUPLINGS AND ELASTOMERIC GASKETS WITH A MINIMUM 4 BANDS PER COUPLING.
  - SLOPE OF DRAINAGE SYSTEM SHALL BE 1/8" PER FOOT OF RUN FOR PIPE OVER 3" (I.D.) AND 1/4" PER FOOT OF RUN FOR PIPE 3" AND SMALLER (I.D.). VENT PIPING SHALL BE PITCHED TO DRAIN.

- ALL CAST IRON SOIL PIPE AND FITTINGS SHALL BE MARKED WITH THE COLLECTIVE TRADEMARK OF THE CAST IRON SOIL PIPE INSTITUTE (CISPI) AND BE LISTED BY NSF INTERNATIONAL.

**A.1 DOMESTIC WATER PIPING:**

- ABOVE GRADE WATER PIPING SHALL BE TYPE 'L' HARD-DRAWN COPPER TUBE.
- FITTINGS IN DOMESTIC WATER PIPING SHALL BE WROUGHT COPPER OR CAST BRASS.
- JOINTS SHALL BE MADE WITH LEAD-FREE SOLDER.
- THE ENTIRE DOMESTIC WATER DISTRIBUTION SYSTEM SHALL BE INSULATED INCLUDING ALL VALVES, FITTINGS, ETC.
- COMPLY WITH NSF 61 FOR MATERIALS FOR WATER-SERVICE PIPING AND SPECIALTIES FOR DOMESTIC WATER.
- ALL DOMESTIC WATER PIPING ABOVE GRADE SHALL BE INSULATED WITH FIRE-RETARDANT FACTORY APPLIED JACKET. PROVIDE COLD WATER PIPING WITH FACTORY-APPLIED VAPOR BARRIER. INSULATION REQUIREMENT SHOULD COMPLY WITH CALIFORNIA STATE ENERGY CODE 2022, SECTION 150.0.
- AS PER CALIFORNIA STATE ENERGY CODE 2022, SERVICE WATER HEATING EQUIPMENT SHALL BE EQUIPPED WITH AUTOMATIC TEMPERATURE CONTROLS CAPABLE OF ADJUSTING FROM THE LOWEST TO THE HIGHEST ACCEPTABLE TEMPERATURE SETTING FOR THE INTENDED USE AS PER TABLE 3, CHAPTER 50 OF ASHRAE HANDBOOK.
- AS PER CALIFORNIA STATE ENERGY CODE 2022, SYSTEMS DESIGNED TO MAINTAIN USAGE TEMPERATURES IN HOT WATER PIPES, SUCH AS RECIRCULATING HOT WATER SYSTEMS SHALL BE EQUIPPED WITH AUTOMATIC TIME SWITCHES OR OTHER CONTROLS THAT CAN BE SET TO SWITCH OF THE USAGE TEMPERATURE MAINTENANCE SYSTEM DURING EXTENDED PERIOD WHEN HOT WATER IS NOT REQUIRED.
- AS PER CALIFORNIA STATE ENERGY CODE 2022, SECTION 110.3, TEMPERATURE CONTROL VALVE SHALL BE PROVIDED TO AUTOMATICALLY REGULATE THE TEMPERATURE OF HOT WATER DELIVERED TO PLUMBING FIXTURE TO A RANGE OF 105°F (41°C) MINIMUM TO 120°F (49°C) MAXIMUM.

- INSULATION REQUIREMENT SHOULD COMPLY WITH CALIFORNIA STATE ENERGY CODE 2022. REFER BELOW TABLE FOR MINIMUM PIPE INSULATION THICKNESS ACC. TO CALIFORNIA PLUMBING CODE 2022 SECTION 609.12, 2022 CALIFORNIA ENERGY CODE 2022 SECTION 120.3

FLUID OPERATING TEMPERATURE RANGE AND USAGE (°F)	INSULATION CONDUCTIVITY		NOMINAL PIPE OR TUBE SIZE (INCHES)	
	CONDUCTIVITY (BTU IN./(H FT2 °F))	MEAN RATING TEMPERATURE, °F	< 1	1 to < 1 1/2
141-200	0.25-0.29	125	1.5	1.5
105-140	0.22-0.28	100	1.0	1.5

- SEAL ALL JOINTS BETWEEN SEGMENTS OF INSULATION.
- PROVIDE SHIELDS BETWEEN HANGERS AND INSULATION.

**B. HANGERS AND SUPPORTS:**

- HANGERS SHALL BE STANDARD STEEL, MALLEABLE OR WROUGHT IRON, AS MANUFACTURED BY GRINNELL OR APPROVED EQUAL, SUITABLE FOR THE TYPE OF CONSTRUCTION. PIPING SHALL NOT BE HUNG FROM OTHER PIPE.
- SECTIONS OF INDIVIDUAL PIPE RUNS SHALL BE SUPPORTED BY CLEVIS HANGERS.
- ALL EQUIPMENT SHALL BE PROVIDED WITH APPROVED SUPPORTS.
- PROVIDE SEISMIC RESTRAINTS IN ACCORDANCE WITH ALL APPLICABLE FEDERAL, STATE AND LOCAL CODES AND STANDARDS AND THE REQUIREMENTS OF AUTHORITIES HAVING JURISDICTION.
- SUPPORTS SHALL BE PROVIDED IN STRICT ACCORDANCE WITH THE RECOMMENDATIONS OF THE PIPING MANUFACTURER.

**C. VALVES:**

- PROVIDE GATE VALVES, BUTTERFLY OR BALL VALVES FOR SHUT-OFF DUTY ON MAIN AND BRANCH SUPPLY LINES. FOR ALL PIPE RUNS 2" AND SMALLER, PROVIDE BALL FOR ALL PIPE RUNS LARGER THAN 2" AND SMALLER THAN 4", PROVIDE GATE VALVES. PIPING 4" AND LARGER, PROVIDE BUTTERFLY VALVES FOR SHUT-OFF DUTY.
- ALL FIXTURES WITH THE EXCEPTION OF FLUSHMETER-EQUIPPED WATER CLOSETS AND URINALS SHALL HAVE STOP VALVES TO CONTROL SUPPLY TO THE FIXTURE. WHERE SUPPLIES ARE EXPOSED PROVIDE CHROME-PLATED STOPS WITH CHROME-PLATED ESCUTCHEONS ON PIPING PENETRATIONS.
- ALL PLUMBING FIXTURES AND EQUIPMENT TO HAVE SHUT-OFF VALVES ON SUPPLY LINES.
- ALL BRANCH LINES TO HAVE SHUT-OFF VALVES.
- ALL VALVES SHALL BE ACCESSIBLE. PROVIDE ACCESS DOORS WHERE REQUIRED FOR VALVE ACCESS.
- PROVIDE GLOBE VALVES FOR THROTTLING/BALANCING OF THE HOT WATER CIRCULATING SYSTEM.

- INSTALL PIPING TO CONSERVE BUILDING SPACE. DO NOT INTERFERE WITH USE OF BUILDING SPACE AND THE WORK OF OTHER TRADES. ALL PIPING RUN IN CEILING SHALL BE INSTALLED TIGHT TO THE STRUCTURE ABOVE.

- INSTALL PIPING TO ALLOW FOR EXPANSION AND CONTRACTION WITHOUT STRESSING PIPE, JOINTS OR CONNECTED EQUIPMENT. PROVIDE PIPE ANCHORS, GUIDES AND EXPANSION JOINTS OR LOOPS IN ALL HOT WATER AND HOT WATER CIRCULATING MAIN SUPPLY PIPING AND SEGMENTS OF SUCH PIPE THAT EXCEED 30'-0" IN LENGTH.

- IN ALL AREAS WITH FINISHED SURFACES, SYSTEM PIPING AND COMPONENTS SHALL BE CONCEALED ABOVE OR WITHIN FINISHED SURFACES.

- REDUCTIONS IN PIPE SIZES SHALL BE MADE WITH ONE-PIECE REDUCING FITTINGS. BUSHINGS ARE NOT ACCEPTABLE. USE FLANGED FITTINGS AT THE BASE OF RISERS.

- VENT PENETRATIONS THROUGH THE ROOF SHALL BE FLASHED.

- IF WATER PRESSURE EXCEEDS 80 PSI, A WATER PRESSURE REDUCING VALVE SHALL BE INSTALLED IN WATER PIPING AT CONNECTION TO MAIN.

- PROVIDE DIELECTRIC FITTINGS BETWEEN DISSIMILAR METALS.

- PIPE BACKFLOW PREVENTER DRAINS TO FLOOR DRAIN OR OTHER APPROVED INDIRECT WASTE SOURCE.

- PROVIDE ACCESS DOORS/PANELS FOR SERVICE AND ACCESS TO ALL VALVES AND OTHER SYSTEM COMPONENTS ENCLOSED IN WALLS AND CEILINGS. ACCESS DOORS SHALL BE FURNISHED BY THIS CONTRACTOR, INSTALLED BY THE GENERAL CONTRACTOR.

- ALL FIXTURES REQUIRING VACUUM BREAKERS SHALL BE EQUIPPED WITH INTEGRAL VACUUM BREAKERS.

- ANY PENETRATIONS THROUGH FIRE RATED PARTITIONS, FLOORS, OR CEILINGS SHALL BE STEEL SLEEVED AND SEALED WITH 3M BRAND UL RATED FIRE BARRIER CAULK OR APPROVED EQUAL.

- WHEN THE WATER PIPING SYSTEM IS COMPLETE, THOROUGHLY FLUSH ALL DIRT, SEDIMENT, SOLDER, ETC., OUT OF THE SYSTEM, REMOVING ALL STRAINERS, VALVE STEEL SEATS, ETC., REQUIRED TO ACCOMPLISH THE FLUSHING.

- AT ALL INDIRECT WASTE DRAINS, MAINTAIN AIR GAP AS REQUIRED BY CODE.

- INSTALL SLEEVES FOR ALL PIPES WHICH PASS THROUGH WALLS, FLOORS, AND CEILINGS. WHERE PIPES ARE TO BE INSULATED, THE SLEEVE SHALL BE LARGE ENOUGH TO ACCOMMODATE INSULATION. SLEEVES SHALL BE FLUSH WITH FINISHED SURFACES AT BOTH ENDS. ON FINISHED SURFACES IN EXPOSED AREAS PROVIDE ESCUTCHEONS COMPATIBLE WITH FINISH.

**S. 2. INSTALLATION**

**2.01 GENERAL**

- ALL WORK WHICH REQUIRES DISRUPTION OF THE ROOFING SHALL BE DONE BY A CONTRACTOR CERTIFIED BY THE ROOFING MANUFACTURER AS REQUIRED TO MAINTAIN ANY EXISTING ROOF WARRANTIES.

- EXTERIOR INSTALLATIONS TO BE WEATHER PROOF IN ALL RESPECTS.

- EXTERIOR MATERIALS AND EQUIPMENT SHALL BE PAINTED TO PREVENT CORROSION, COLOR PER ARCHITECT.

- COORDINATE THE PLUMBING WORK WITH ALL OTHER AFFECTED WORK AND THE CONSTRUCTION SCHEDULE.

- REAM PIPE AND TUBE ENDS. REMOVE BURRS. BEVEL PLAIN AND FERROUS END PIPE.

- REMOVE SCALE AND FOREIGN MATERIAL, FROM INSIDE AND OUTSIDE, BEFORE ASSEMBLY.

- PREPARE PIPING CONNECTIONS TO EQUIPMENT WITH FLANGES AND UNIONS.

- COORDINATION WITH THE WORK OF OTHER TRADES IS REQUIRED. PROVIDE OFFSETS IN PIPING SYSTEMS OR MINOR DEVIATIONS TO THE INDICATED PIPE ROUTING IN ORDER TO COORDINATE THE PLUMBING WORK WITH THE WORK OF ALL OTHER TRADES AND THE GENERAL BUILDING CONDITIONS.

- NO DOMESTIC WATER PIPING SHALL BE INSTALLED IN UNHEATED SPACES.

- PRIOR TO DISCONNECTING AND CONNECTING NEW WORK TO EXISTING SYSTEMS, THE PLUMBING CONTRACTOR SHALL NOTIFY THE PROPERTY MANAGER AND OFFER A PROPOSED SCHEDULE OF WORK. ESB WILL AUTHORIZE CONNECTIONS AND COORDINATE NECESSARY SHUT DOWNS AND DRAIN DOWNS AS REQUIRED. SHUT DOWNS AND DRAIN DOWNS MAY BE PERFORMED BY THE PLUMBING CONTRACTOR ONLY AFTER RECEIVING ESB AUTHORIZATION, AND SHOULD BE PERFORMED UNDER SUPERVISION OF ESB PERSONNEL. THREE (3) DAYS ADVANCE NOTICE TO THE PROPERTY MANAGER IS REQUIRED.

- THE PLUMBING CONTRACTOR IS ADVISED THAT DUE TO THE NATURE OF THE OPERATIONS AND TENANT REQUIREMENTS, CONNECTIONS TO EXISTING SYSTEMS MAY HAVE TO BE MADE AFTER REGULAR WORKING HOURS. THE PROPERTY MANAGER WILL ADVISE THE PLUMBING CONTRACTOR OF THE TIME CONSTRAINTS UPON RECEIPT AND APPROVAL OF THE PLUMBING CONTRACTOR'S REQUEST FOR SHUT DOWN AND CONNECTION TO EXISTING SYSTEMS.

- WHEN CONNECTING TO EXISTING STACKS AND RISERS, PROVISION IS TO BE MADE FOR FUTURE CONNECTIONS BY PROVIDING CAPPED AND VALVED OUTLETS ON DOMESTIC WATER RISERS AND PLUGGED OUTLETS ON THE SANITARY AND VENT STACKS.

**2.02 ABOVE GRADE**

- INSTALL PLUMBING PIPING IN ACCORDANCE WITH RECOGNIZED INDUSTRY PRACTICES TO ENSURE THAT PIPING COMPLIES WITH REQUIREMENTS AND SERVES INTENDED PURPOSES.

- ROUTE PIPING IN AN ORDERLY MANNER, PLUMB AND PARALLEL TO BUILDING STRUCTURE. MAINTAIN GRADIENT. SLOPE PIPING AND ARRANGE SYSTEMS TO DRAIN IN DOMESTIC WATER SYSTEMS. PROVIDE DRAIN VALVES AT MAIN SHUT-OFF VALVES AND ALL LOW POINTS IN PIPING.

- USE EXISTING CONNECTIONS AT MAINS WHERE AVAILABLE FOR NEW BRANCH PIPING. LOCATE ALL RISERS AND PIPING BEFORE CONSTRUCTION COMMENCES AND TAKE CARE NOT TO DAMAGE SAME. ANY DAMAGE OCCURRING TO THE EXISTING PIPING WILL BE THE SOLE RESPONSIBILITY OF THE CONTRACTOR.

**3. TESTING**

- AT THE COMPLETION OF THE PLUMBING WORK, COMPLETELY TEST THE ENTIRE INSTALLATION OF ALL SYSTEMS FOR PROPER OPERATION AND COMPLIANCE WITH APPLICABLE CODES AND LOCAL REQUIREMENTS. CORRECT ALL DEFICIENCIES FOUND.

- TESTING OF THE INSTALLED SYSTEMS SHALL BE MADE BY THE CONTRACTOR IN THE PRESENCE OF REPRESENTATIVE A OF THE OWNER.

- THE CONTRACTOR SHALL NOT COVER UP OR PERMANENTLY CONCEAL PIPING, DEVICES OR ANY PORTION OF NEWLY CONSTRUCTED PLUMBING SYSTEM(S) UNTIL SUCH SYSTEM, OR PORTION OF THE SYSTEM, HAS BEEN TESTED IN THE PRESENCE OF A REPRESENTATIVE OF THE OWNER AND INSPECTED BY THE LOCAL INSPECTOR AND APPROVED IN WRITING, EXCEPT PIPING PASSING THROUGH FLOORS, WALLS, PARTITIONS, OR BEAMS, FOR DISTANCES EQUAL TO THE THICKNESS OF SUCH FLOOR, WALL, PARTITION OR BEAM.

- THIS CONTRACTOR SHALL NOTIFY THE VARIOUS DEPARTMENTS, BUREAUS AND INDIVIDUALS AT LEAST TWO WEEKS IN ADVANCE OF THE TIME THAT THE TESTS ARE TO BE CONDUCTED.

- ALL DEFECTIVE PARTS SHALL BE REPLACED OR CORRECTED BY THIS CONTRACTOR AND AN EXTRA TEST OR TESTS SHALL BE MADE UNTIL THE OPERATION IS SATISFACTORY. ALL ARRANGEMENTS AND EXPENSES NECESSARY TO CONDUCT ALL TESTS REQUIRED BY THESE SPECIFICATIONS AND THE VARIOUS AGENCIES HAVING JURISDICTION OVER THE WORK INSTALLED UNDER THIS CONTRACT SHALL BE MADE BY THIS CONTRACTOR. NO EXTRA COMPENSATION WILL BE ALLOWED FOR THESE TESTS, THE COST THEREOF BEING INCLUDED IN THE LUMP SUM BID FOR THIS CONTRACT.

- WHERE ANY EVIDENCE OF STOPPAGE IS FOUND IN PIPING OR EQUIPMENT, THIS CONTRACTOR SHALL DISCONNECT, CLEAN, REPAIR AND RECONNECT ALL OBSTRUCTED PIPING OR EQUIPMENT AND SHALL ALSO PAY FOR ALL NECESSARY CUTTING AND REPAIRS TO ADJOINING WORK.

- ALL PIPING AND EQUIPMENT SHALL BE THOROUGHLY CLEANED INSIDE AND OUT, OF DIRT, CUTTINGS, OILS AND OTHER FOREIGN SUBSTANCES AND SHALL BE LEFT CLEAN.

- ALL REQUIRED TESTS SHALL BE WITNESSED BY LOCAL AUTHORITIES AND THE OWNER'S REPRESENTATIVE.

- ALL EQUIPMENT WILL BE FACTORY TESTED.

- CONTRACTOR SHALL IDENTIFY TO THE OWNER'S REPRESENTATIVE ANY LEAKS OR DAMAGE THAT OCCURS AS A RESULT OF SYSTEM TESTING. CONTRACTOR SHALL TAKE NECESSARY PRECAUTIONS TO LIMIT ANY POTENTIAL DAMAGE. CORRECTIVE ACTION REQUIRED AS A RESULT OF TESTING SHALL BE PERFORMED IMMEDIATELY AND AT THE CONTRACTOR'S EXPENSE.

- REPORT IN WRITING TO AUTHORITIES HAVING JURISDICTION, THE ARCHITECT AND THE OWNER THE RESULTS OF ALL TESTING.

**L. TESTING REQUIREMENTS**

- TEST ALL DOMESTIC WATER PIPING HYDROSTATICALLY TO 125 PSIG.
- HYDROSTATIC TEST PRESSURES SHALL REMAIN CONSTANT WITH NO VARIATION FOR 120 MINUTES.
- TESTS SHALL BE WITNESSED BY THE BUILDING ENGINEER.
- THE PLUMBING CONTRACTOR WILL BE HELD RESPONSIBLE FOR ALL DAMAGE DUE TO TEST FAILURES AND LEAKAGE IN THE TEST AREA AND ADJACENT TENANT OR ESB SPACES.

- REFILL ENTIRE POTABLE HOT AND COLD WATER SUPPLY SYSTEM WITH CHLORINE SOLUTION (HTH OLIN CHEMICAL CORP.) AT A STRENGTH TO MEET STANDARDS OF THE DEPARTMENT OF HEALTH, AND FOR A PERIOD OF RETENTION AS STIPULATED.

- THOROUGHLY FLUSH PIPING SYSTEM WITH FRESH WATER IMMEDIATELY PRIOR TO FINAL ACCEPTANCE.

**4. WARRANTY**

- EQUIPMENT, MATERIALS AND WORKMANSHIP FURNISHED UNDER THIS CONTRACT SHALL BE GUARANTEED BY THE CONTRACTOR FOR A PERIOD OF ONE YEAR FROM THE DATE OF FINAL ACCEPTANCE OF THE WORK BY THE OWNER. THE CONTRACTOR SHALL KEEP THE WORK IN GOOD REPAIR FOR ONE YEAR AFTER THE DATE OF FINAL APPROVAL. THE CONTRACTOR SHALL, AT HIS OWN EXPENSE, PROMPTLY CORRECT AND REPAIR ANY AND ALL BREAKS, FAILURES OR WEAR DUE TO FAULTY MATERIALS, WORKMANSHIP OR EQUIPMENT. ALL SETTLEMENTS OF SURFACES THAT MAY OCCUR WITHIN THAT PERIOD SHALL ALSO BE PROMPTLY REPAIRED.



**Issue For Description:**


**Issue Date:**

**GENERAL NOTES:**

1. CW/HW PIPING PROVIDED WITH INSULATION AS PER 2022 CALIFORNIA ENERGY CODE.
2. PROVIDE BRANCH PRV IF PRESSURE EXCEEDS 80 PSI.
3. PROVIDE ACCESS PANELS FOR WATER HAMMER ARRESTOR, CLEANOUTS & SHUT-OFF VALVES AS REQUIRED.
4. REFER RISER DIAGRAMS FOR ALL PIPE SIZES.
5. CONTRACTOR TO FIELD VERIFY THAT THE BACKFLOW PREVENTION DEVICE SHALL BE ASSE 1013 OR SIMILAR APPROVED AS PER LOCAL JURISDICTION, AND, PROVIDE REQUIRED AIR GAP TO AFFORD BACKFLOW PREVENTION PROTECTION AS PER 2022 CPC SECTION 603.3.1.
6. ANY UNUSED EXISTING PLUMBING PIPING MUST BE COMPLETELY REMOVED OR CAPPED. DO NOT ABANDON IN PLACE.

**WATER PIPING KEYED NOTES:**

1. EXTEND AND CONNECT NEW 1" CW LINE TO EXISTING CW LINE IN SPACE. CONTRACTOR TO FIELD VERIFY CW LINE CONDITION, LOCATION AND SIZE OF EXISTING CW LINE.
2. EXTEND AND CONNECT NEW 1/2" CW/HW LINE TO EXISTING CW/HW LINE. CONTRACTOR TO FIELD VERIFY EXISTING WATER LINE SIZE, ROUTING AND LOCATION.
3. EXTEND AND CONNECT NEW 3/4" CW/HW LINE TO EXISTING CW/HW LINE. CONTRACTOR TO FIELD VERIFY EXISTING WATER LINE SIZE, ROUTING AND LOCATION.
4. NEW FILTRATION SYSTEM. COORDINATE WITH LANDLORD/ ARCHITECT FOR FINAL LOCATION.
5. CONTRACTOR TO VERIFY AVAILABILITY OF EXISTING BFP AND WATER METER. PROVIDE NEW IF NOT EXISTING. INSTALL BFP AND WATER METER AS PER LOCAL JURISDICTION REQUIREMENT. BASE BID ACCORDINGLY. COORDINATE WITH LANDLORD/ ARCHITECT FOR FINAL LOCATION.
6. CONTRACTOR TO FIELD VERIFY THE CONDITION OF EXISTING PIPING AND REUSE. PROVIDE NEW AS SHOWN ON PLAN IF NOT WORKING. BASE BID ACCORDINGLY.
7. PROVIDE ASSE 1022 APPROVED BACKFLOW PREVENTOR TO ICE MACHINE FOR BACKFLOW PREVENTION. INSTALL BFP AN ACCESSIBLE LOCATION.
8. ROUTE WATER HEATER T&P RELIEF DRAIN TO ADJACENT EXISTING FLOOR DRAIN. CONTRACTOR TO FIELD VERIFY EXACT LOCATION OF EXISTING FLOOR DRAIN.

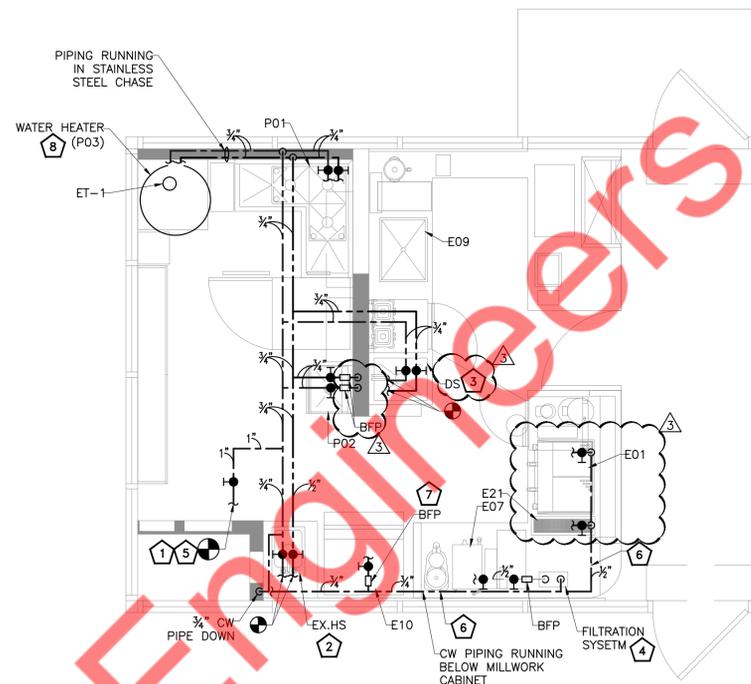

**PLUMBING WATER PLAN**

SCALE  
3/8"=1'-0"


1

**GENERAL NOTES:**

1. REFER RISER DIAGRAMS FOR ALL PIPE SIZES.
2. REUSE EXISTING PLUMBING PIPING AND FIXTURES WHERE EVER POSSIBLE. COORDINATE WITH ARCHITECT/LANDLORD BEFORE REUSE. BASE BID ACCORDINGLY.
3. ANY UNUSED EXISTING PLUMBING PIPING MUST BE COMPLETELY REMOVED OR CAPPED. DO NOT ABANDON IN PLACE.

**SANITARY PIPING KEYED NOTES:**

1. PROVIDE REQUIRED SLOPE FOR THE SANITARY PIPING AS PER THE LOCAL CODE.
2. CONNECT NEW 4" GREASE WASTE PIPING TO EXISTING GREASE WASTE LINE IN SPACE. CONTRACTOR TO FIELD VERIFY SIZE, ROUTING AND INVERT. CONTRACTOR TO FIELD VERIFY THE LOCATION, CONDITION AND CAPACITY OF EXISTING GREASE INTERCEPTOR IS MORE OR EQUAL THAN 750 GALLONS AND PROVIDE NEW IF EXISTING IS NOT SUFFICIENT.
3. CONNECT NEW 3" VENT LINE CONNECT TO EXISTING VENT LINE IN SPACE. CONTRACTOR TO FIELD VERIFY EXISTING VENT LINE EXACT LOCATION AND SIZE. UPDATE IF REQUIRED.
4. REPLACE EXISTING PLUMBING FIXTURE WITH NEW MOP SINK (P02) WITH EXISTING WASTE, VENT PIPING WITH ASSOCIATED ACCESSORIES AND FITTINGS TO REMAIN. CONTRACTOR TO FIELD VERIFY EXISTING CONDITION AND SIZE OF PIPING, UPGRADE IF REQUIRED.
5. REROUTE DRAIN FROM EXISTING FLOOR SINK LOCATED BELOW 1-COMP SINK TO THE GREASE WASTE LINE IN SPACE. CONTRACTOR TO FIELD VERIFY EXACT LOCATION, SIZE AND INVERT PRIOR TO ROUGH-IN.
6. REPLACE EXISTING DUMP SINK WITH NEW DUMP SINK WITH EXISTING INDIRECT WASTE, VENT PIPING WITH ASSOCIATED ACCESSORIES AND FITTINGS TO REMAIN. CONTRACTOR TO FIELD VERIFY EXISTING CONDITION OF PIPING AND FIXTURE. REPLACE IF REQUIRED.
7. EXISTING HAND SINK WITH EXISTING SANITARY, VENT WITH ASSOCIATED ACCESSORIES AND FITTINGS TO REMAIN. CONTRACTOR TO FIELD VERIFY EXISTING CONDITION OF PIPING AND FIXTURE. REPLACE IF REQUIRED.
8. INDIRECT WASTE FROM DUMP SINK, ICE BIN (E09), 3-COMP SINK (P01) AND MOP SINK (P02) TO THE ADJACENT EXISTING FLOOR SINK WITH APPROVED AIR GAP.
9. ROUTE DRAIN LINE FROM WATER FILTER (E12) TO ADJACENT EXISTING FLOOR SINK WITH APPROVED AIR GAP.
10. EXISTING FLOOR DRAIN/FLOOR SINK WITH EXISTING SANITARY, VENT WITH ASSOCIATED ACCESSORIES AND FITTINGS TO REMAIN. CONTRACTOR TO FIELD VERIFY EXISTING CONDITION OF PIPING AND FIXTURE. REPLACE IF REQUIRED.
11. INDIRECT DRAIN FROM ICE MACHINE (E10), SINGLE COFFEE BREWER (E07), LINEA PB W (E01) AND PITCHER RINSE (E24) TO ADJACENT EXISTING FLOOR SINK WITH APPROVED AIR GAP.

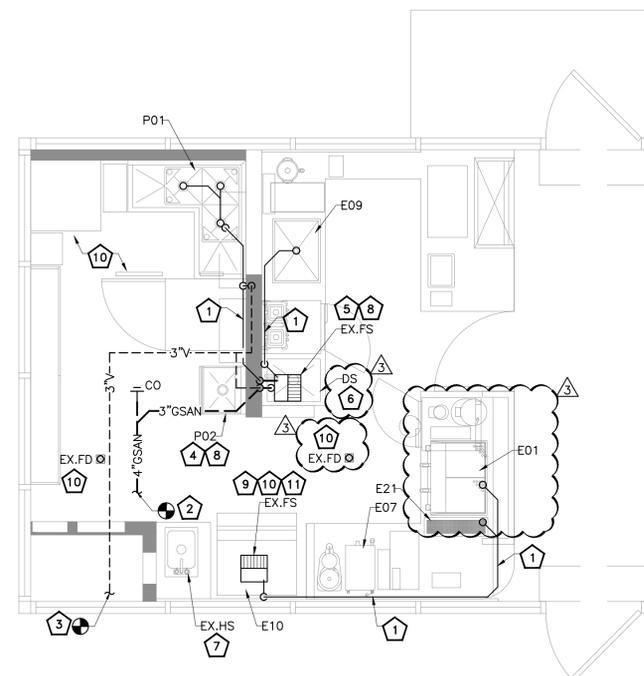

**PLUMBING SANITARY AND VENT PLAN**

SCALE  
3/8"=1'-0"

2

Project Owner:

**Chamberlain  
Coffee**

Issue For Description:

Issue Date:

09.10.24

Revisions:


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△	CITY COMMENTS	10.02.24
△	HEALTH DEPARTMENT COMMENTS	10.21.24

Sheet Title:


PLUMBING PLANS

Sheet Number:



P100

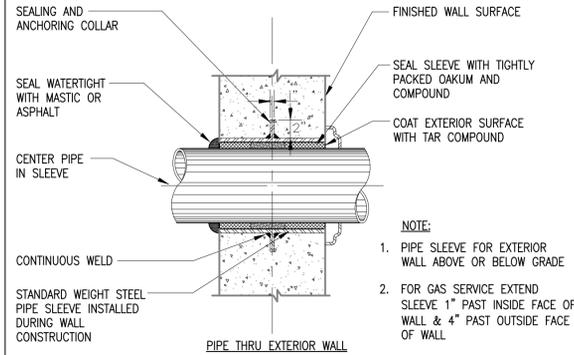


1 PIPE SLEEVE THRU WALL SECTION  
P200 N.T.S

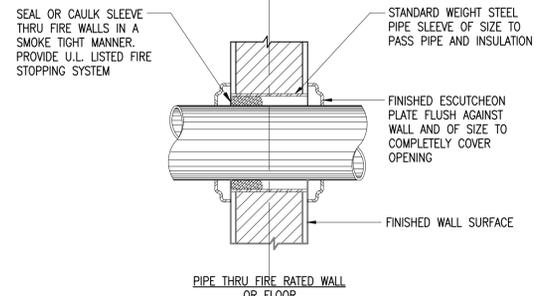


2 ELECTRIC WATER HEATER DETAILS  
P200 N.T.S

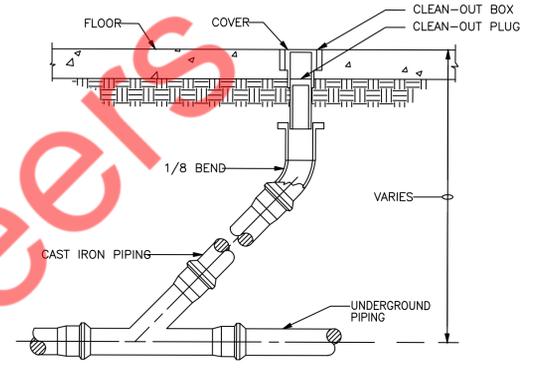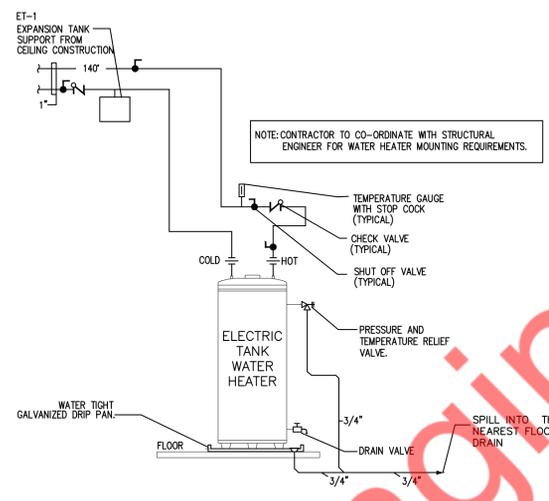


3 FLOOR CLEANOUT DETAIL  
P200 N.T.S

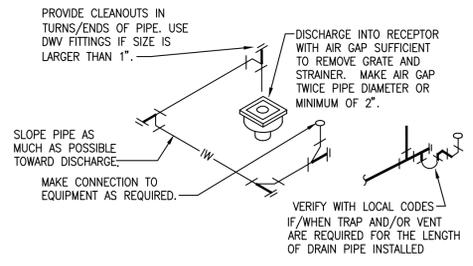

4 INDIRECT WASTE CONNECTION DETAIL  
P200 N.T.S

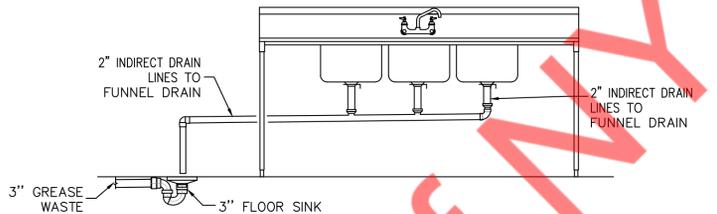


6 3-COMP. SINK/GREASE TRAP DETAIL  
P200 N.T.S

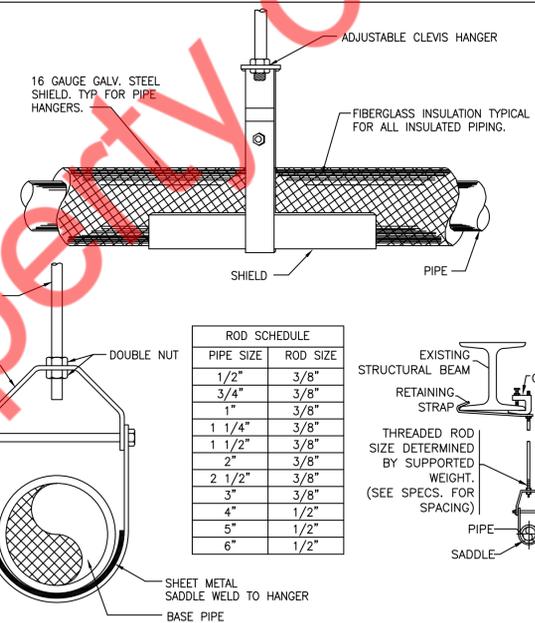


7 HANGER DETAIL  
P200 N.T.S


8 NOT USED  
P200 N.T.S

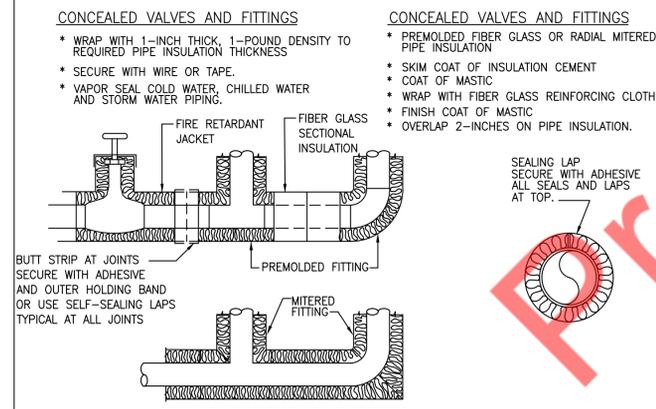

5 INSULATION OF PIPING, VALVES AND FITTINGS FOR EXPOSED AND CONCEALED LOCATIONS  
P200 N.T.S

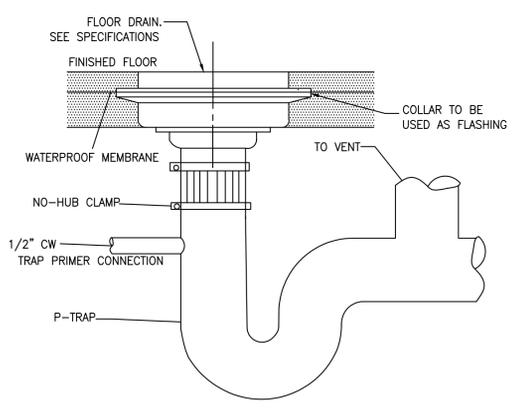

9 FLOOR DRAIN DETAIL  
P200 N.T.S

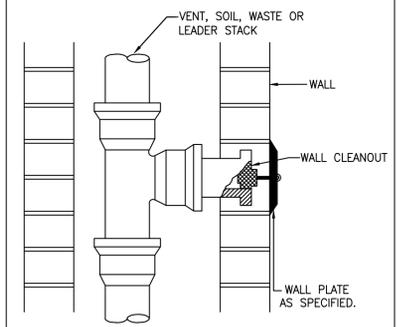

10 WALL CLEANOUT DETAIL  
P200 N.T.S

Project Owner:



Issue For Description:

Issue Date:

09.10.24

Revisions:


NO.	DESCRIPTION	DATE
1	ELECTRICAL COMMENTS	10.01.24
2	CITY COMMENTS	10.02.24
3	HEALTH DEPARTMENT COMMENTS	10.21.24

Sheet Title:

PLUMBING DETAILS

Sheet Number:

P200

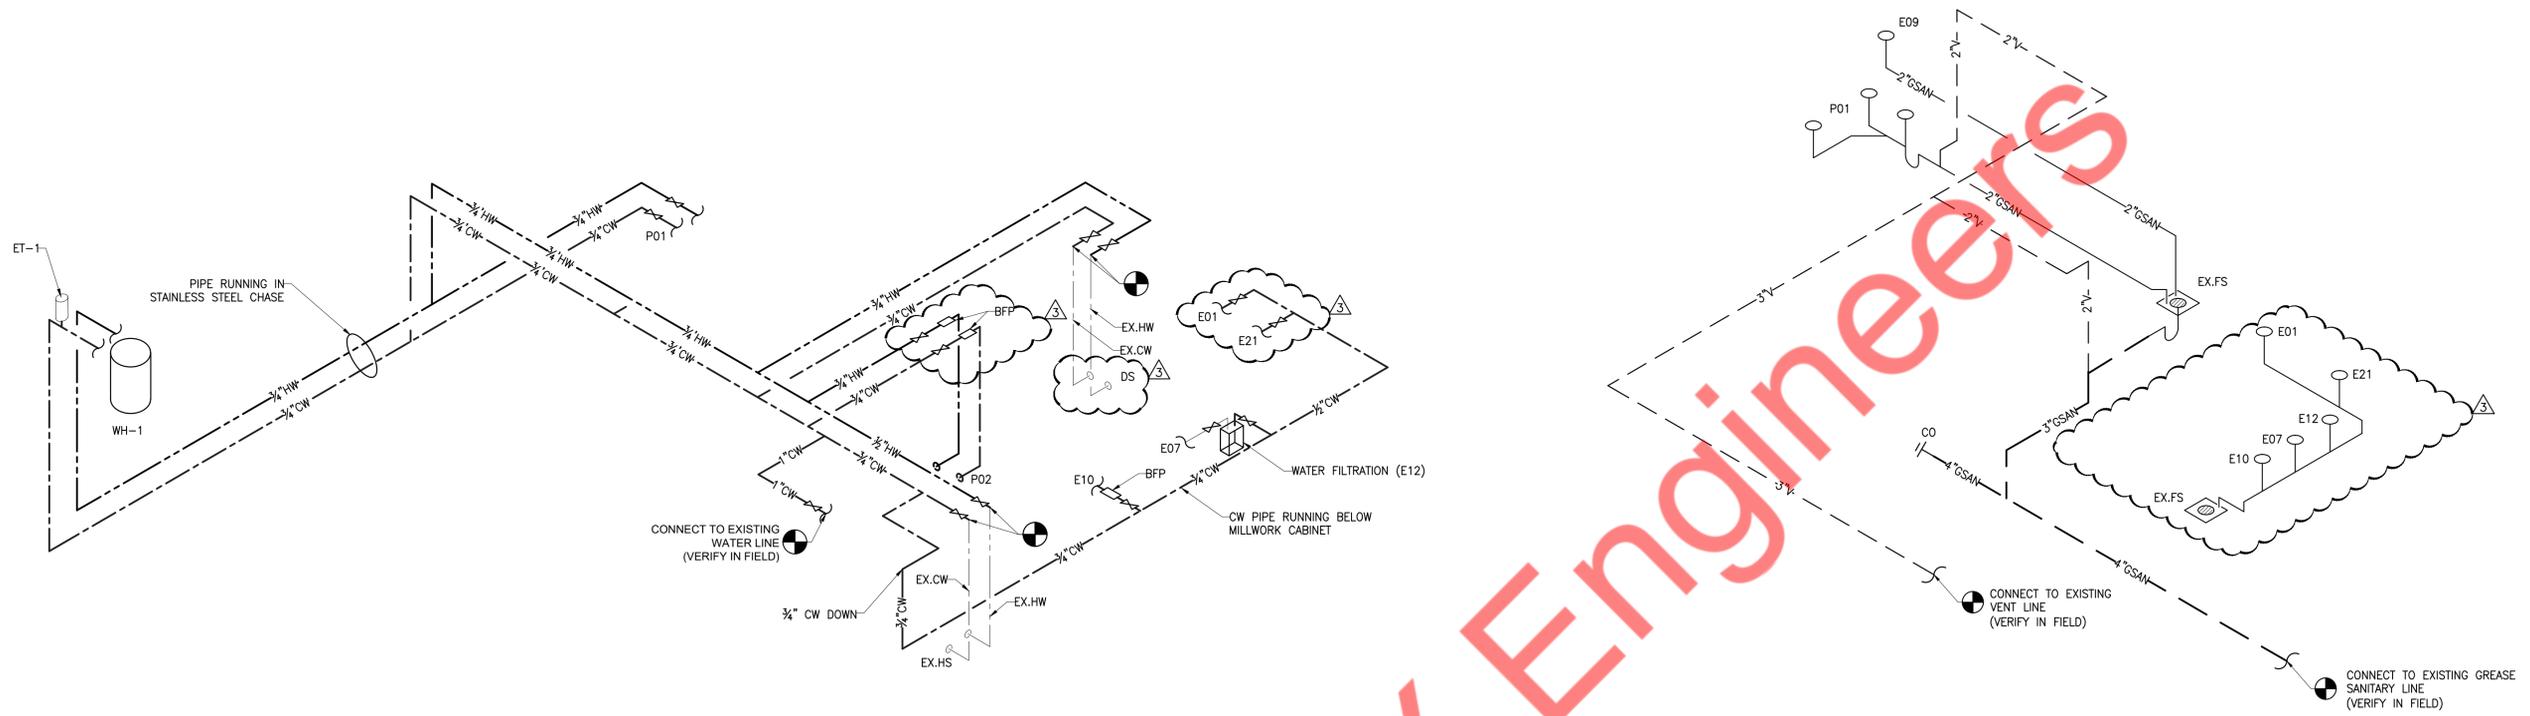

1 DOMESTIC WATER RISER DIAGRAM  
P300 NOT TO SCALE

2 SANITARY WASTE AND VENT RISER DIAGRAM  
P300 NOT TO SCALE

WATER PRESSURE CALCULATION		
AVAILABLE PRESSURE	APPROXIMATE -	50 PSI
PRESSURE ACROSS METER	LOSS -	4 PSI
STATIC PRESSURE (ELEVATION) (12' X 0.43)	LOSS -	5.16 PSI
MINIMUM PRESSURE TO BE MAINTAINED	LOSS -	15 PSI
BACKFLOW PREVENTER (1" RPZ)	LOSS -	12 PSI
TOTAL PRESSURE AVAILABLE		13.84 PSI
DISTANCE FROM METER TO LAST FIXTURE 135'		
TOTAL DEVELOPED LENGTH OF SYSTEM (X 1.25) 189'		
ALLOW. PRESSURE LOSS/100FT	$\frac{13.84 \times 100}{189}$	7.32 PSI
AVERAGE PRESSURE DROP AVAILABLE FOR FRICTION		6.52 PSI

FIXTURE UNIT CALCULATION				
TAG	EQUIPMENT	QTY	WSFU	TOTAL
P01	3-COMP SINK	1	3	3
P02	MOP SINK	1	3	3
E01	LINEA PB W SCALE BUILT IN	1	0.5	0.5
E07	SINGLE COFFEE BREWER	1	0.5	0.5
E11	ICE MACHINE	1	0.5	0.5
EX.HS	HAND SINK	1	1	1
DS	DUMP SINK	1	3	3
TOTAL WATER SUPPLY FIXTURE UNIT			11 = 156GPM	
WSFU VALUES AS PER CALIFORNIA PLUMBING CODE 2022 CHART A 103.1(2) PER CALIFORNIA PLUMBING CODE 2022, CHART A 105(1) FOR 15 GPM CALCULATED PIPE SIZE IS 1"				

PLUMBING FIXTURE SCHEDULE							
LEGEND	PLUMBING FIXTURE	CONNECTION SIZE - INCHES					REMARK
		SOIL/WASTE		VENT	COLD WATER	HOT WATER	
		DIRECT	INDIRECT				
P01	3-COMP SINK	2"	-	2"	3/4"	3/4"	IW TO EX.FS
P02	MOP SINK	3"	-	2"	3/4"	3/4"	-
E01	LINEA PB W SCALE BUILT IN	-	-	-	1/2"	-	IW TO EX.FS
E07	SINGLE COFFEE BREWER	-	-	-	1/2" FW	-	IW TO EX.FS
E09	ICE BIN	-	1"	-	-	-	1' IW TO EX.FS
E10	ICE MACHINE	-	1"	-	1/2"	-	1' IW TO EX.FS
E24	PITCHER RINSE	-	-	-	1/2"	-	IW TO EX.FS
EX.HS	HAND SINK	E	-	-	1/2"	1/2"	-
DS	DUMP SINK	-	2"	-	3/4"	3/4"	-
FD-1	FLOOR DRAIN	E	-	E	-	-	-
FS-1	FLOOR SINK	E	-	E	-	-	-
NOTE: 1. CONTRACTOR TO COORDINATE WITH ARCHITECTURAL DRAWINGS FOR ALL PLUMBING FIXTURES SPECIFICATION.							

ELECTRIC WATER HEATER SCHEDULE														
UNIT	MANUFACTURER & MODEL NUMBER	MAXIMUM PRESSURE (PSI)	UNIT CAPACITY			SYSTEM OUTLET TEMP (°F)	ELECTRICAL DATA				DIMENSIONS			
			STORAGE (GAL)	RECOVERY (GPH)	DEGREE RISE (°F)		NUMBER OF ELEMENTS	POWER (KW)	V	PH	HZ	HEIGHT (INCH)	DIAMETER (INCH)	SHIPPING WEIGHT (LBS)
P03	DEL-50	150	48	51	80	140	2	10.0	208	1	60	36"	26- 1/2"	172

EXPANSION TANKS SCHEDULE									
UNIT	NUMBER	MANUFACTURER & MODEL NUMBER	TANK VOLUME (GAL)	ACCEPTANCE VOLUME (GAL)	PRESSURE RATING (PSI)	DIMENSIONS			
						DIAMETER (INCH)	HEIGHT (INCH)	SHIPPING WEIGHT (LBS)	NOTES
ET-1	1	AMTROL ST-5C-DD	2.0	0.9	150	8	14	10	1,2

- GENERAL NOTES:  
 1. SET THE TANK PRESSURE TO EQUAL THE SYSTEM OPERATING PRESSURE. TANK MUST BE DRAINED BEFORE ADJUSTING SET PRESSURE.  
 2. INSTALL PER MANUFACTURER'S RECOMMENDATIONS ON INCOMING COLD WATER LINE.

GREASE INTERCEPTORS SIZING				
FIXTURE	PIPE SIZE	DFU	QUANTITY	TOTAL DFU'S
3 COMP SINK - P01 (LD TO EX.FS)	2"	-	-	-
MOP SINK - P02	3"	3	1	3
DUMP SINK - DS (LD TO EX.FS)	2"	-	-	-
EXISTING FLOOR SINK (EX.FS)	3"	6	1	6
TOTAL DRAINAGE FIXTURE (DFU) CONNECTED TO GREASE INTERCEPTOR				9
TOTAL MINIMUM REQUIRED GREASE INTERCEPTOR CAPACITY (GALLONS) UPC 2022 SECTION 1014.3.6				750
AVAILABLE EXISTING GREASE INTERCEPTOR CAPACITY ON SITE - 5000 GALLONS				

Project Owner:

Chamberlain Coffee

Issue For Description:

Issue Date:

09.10.24

Revisions:

NO.	DESCRIPTION	DATE
1	ELECTRICAL COMMENTS	10.01.24
2	CITY COMMENTS	10.02.24
3	HEALTH DEPARTMENT COMMENTS	10.21.24

Sheet Title:

PLUMBING SCHEDULES AND RISERS

Sheet Number:

P300